
Apri 26, 2023

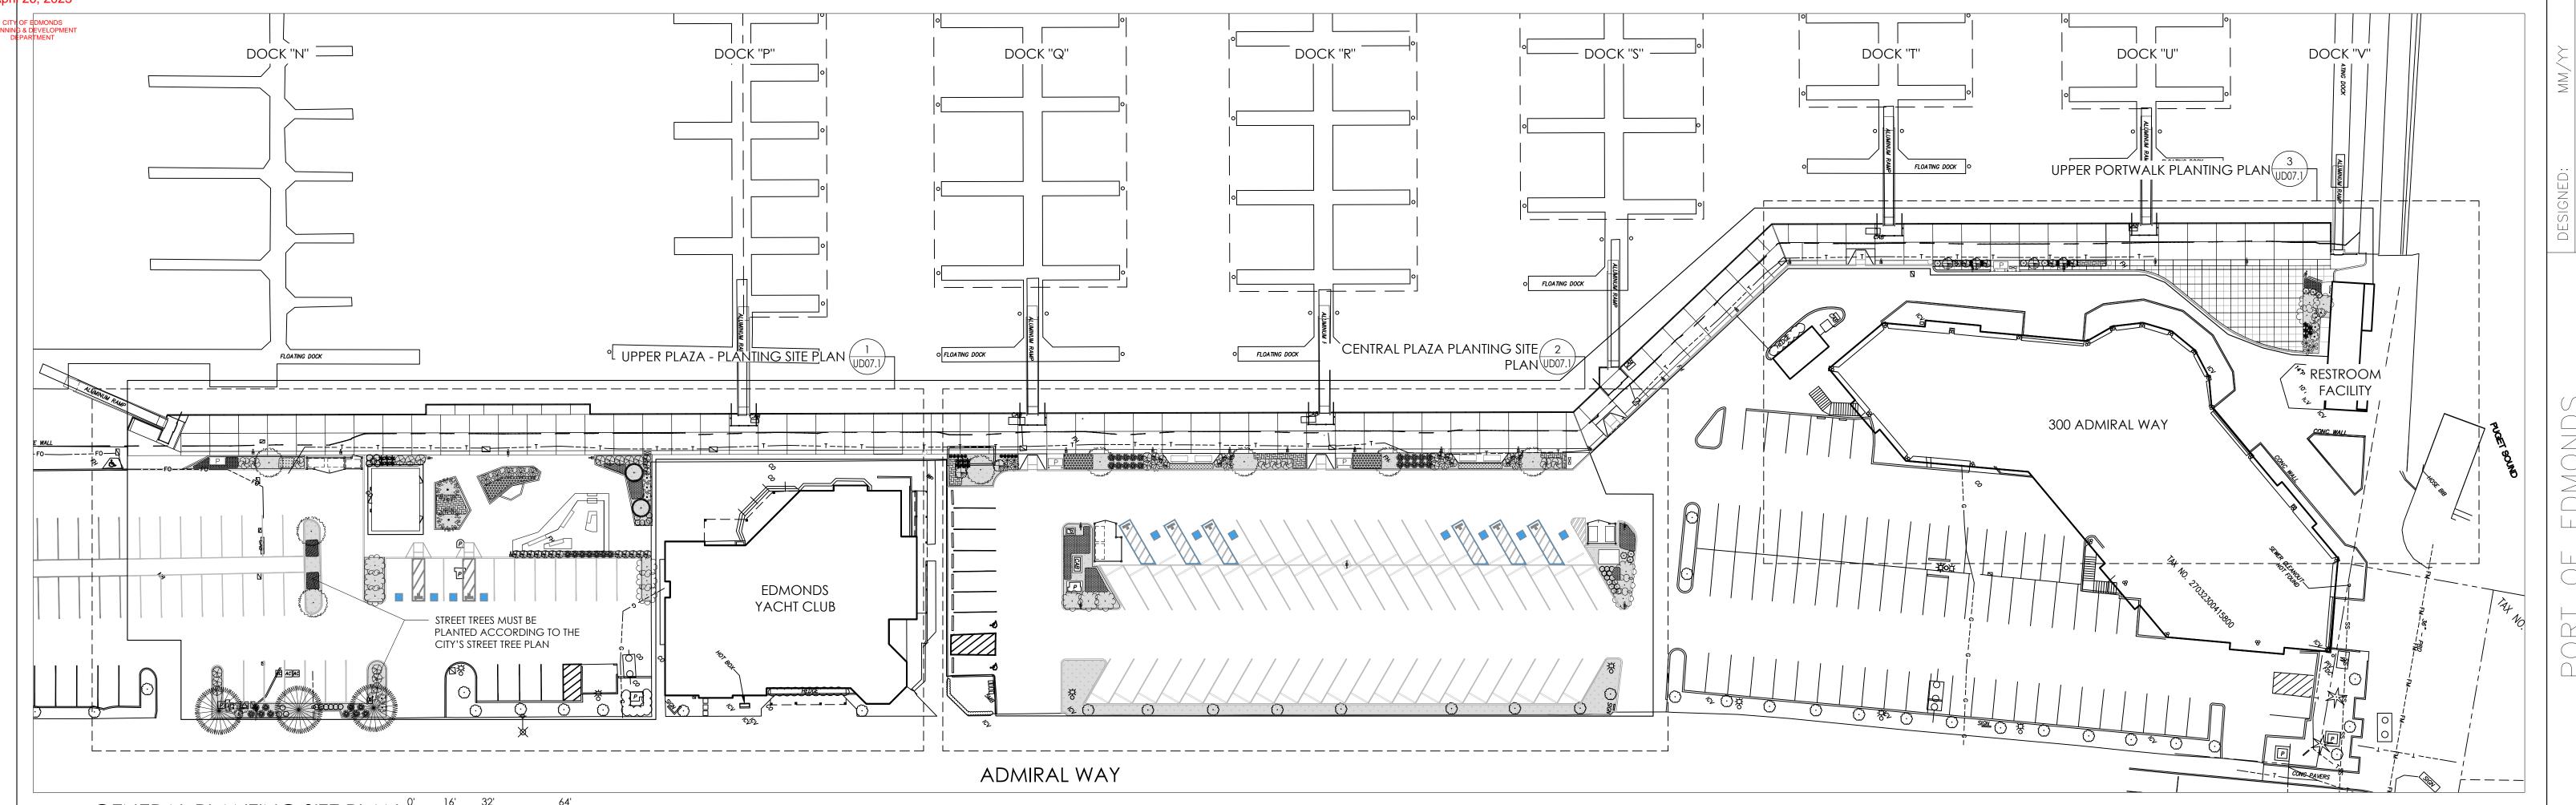

1	GENERAL PLANTING SITE PLAN 1"= 32'-0"	16'	32'	64'

PLANTING SCHEDULE

	Scientific Name	Common Name	Size	Quantity
MANA DONAL	Cornus nuttallii	Pacific Dogwood	3" cal	8
~~	Chamaecyparis obtusa 'Gracilis'	Slender Hinoki Cypress	3" cal	2
J	Prunus serrulata 'Amanogawa'	Amanogawa Flowering Cherry	3" cal	15
	Ginkgo biloba 'Princeton Sentry'	Princeton Sentry Ginkgo		2
	Liquidambar styraciflua	Sweetgum		3
Burgo y	Pinus contorta var. Chief Joseph	Chief Joseph Pine	10 gal	6
	Ceanothus sanguineus	Red Stem Ceanothus	5 gal	7
分	Cornus sericea	Red Osier Dogwood	5 gal	9
	Gaultheria shallon	Salal	3 gal	41
}	Hosta "Guacamole"	Hosta		13
	Lupinus litooralis	Broadleaf Lupine	3 gal	18
And Andrews Land	Mahonia (Berberis) aquifolium	Tall Oregon grape	5 gal	20
	Nandina domestica	Heavenly Bamboo	5 gal	20
}	Ribes sanguineum	Flowering Currant	5 gal	8
	Rosa nutkana	Nootka Rose	5 gal	18
الموسى مراد	Pinus mugo 'Tannenbaum'			
4	or Jakobsen	Mugo Pine	5 gal	3
	Polystichum munitum	Sword fern	3 gal	17
	Sarcococca hookeriana var. humilis	Sweet Box		31
	Armeria maritima	Thrif/Sea Pink		230 SF
	Arctostaphylos uva-ursi	Kinnikinnik	12"x12"	480 SF
;	Daphne odora 'Aureo-marginata'	Winter Daphne		250 SF
3	Deschampsia cespitosa	Tufted Hairgrass	12"x12"	150 SF

NOTES:

- CONTRACTOR SHALL ARRANGE TO MEET ON SITE WITH THE PROJECT REP TO DISCUSS LIMITS OF WORK AND METHODS. CONSTRUCTION ACTIVITIES SHALL NOT COMMENCE UNTIL ACCESS, LMITS OF WORK, AND METHODS ARE APPROVED. ALL SAFETY FENCING AND TESC MEASURES MUST BE INSTALLED PRIOR TO COMMENCING CONSTRUCTION ACTIVITIES.
- 2 ALL PLANTS TO BE SAVED AND PROTECTED WITHIN PLANTING AREAS WILL BE FLAGGED BY ENGINEER. NOTIFY ENGINEER FIVE (5) DAYS PRIOR TO START OF CLEARING ACTIVITY.
- 3 MITIGATION PLANTING PLANS REPRESENT A CONCEPTUAL PLANT LAYOUT.
 FINAL PLANT LOCATIONS SHALL BE APPROVED BY PROJECT REP PRIOR TO
 PLANTING, COORDINATE DATA WILL BE PROVIDED ELECTRONICALLY FOR
 LOCATION OF PLANTING AREA BOUNDARIES.
- 4 ALL PLANTS SHALL BE NURSERY GROWN A MINIMUM OF ONE YEAR, PLANT MATERIAL IS TO BE SUPPLIED BY COMMERCIAL NURSERIES. PLANT SUBSTITUTIONS ARE SUBJECT TO APPROVAL BY PROJECT REP.
- 5 MITIGATION PLANTING SHALL TAKE PLACE DURING THE DORMANT SEASON (OCTOBER 1ST TO MARCH 1ST). PLANTING MAY BE ALLOWED AT OTHER TIMES AFTER REVIEW AND WRITTEN APPROVAL BY PROJECT REP.
- 6 THE CONTRACTOR SHALL BE RESPONSIBLE FOR DISPOSING OF ALL DEBRIS AND EXCESS SOIL OCCASIONED BY THIS PROJECT.
- 7 CONTRACTOR SHALL VERIFY THE LOCATION OF ALL UTILITIES PRIOR TO EXCAVATION.
- 8 ALL DIMENSIONS FOR LISTED HEIGHT, LEGNTH, AND CONTAINER SIZE ARE MINIMUM REQUIREMENTS.
- 9 EXISTING AREAS DISTURBED BY CONSTRUCTION ACTIVITIES AND NOT SHOWN TO BE RE-VEGETATED ON THESE PLANS SHALL BE RESTORED AND SEEDED.
- 10 DISCREPANCIES BETWEEN THE PLANS AND SITE CONDITIONS SHALL BE BROUGHT TO THE ATTENTION OF THE PROJECT REP PRIOR TO PROCEEDING WITH EFFECTED WORK.
- 11 SEE SP SHEETS FOR TEMPORARY EROSION CONTROL MEASURES.
- 12 CONTRACTOR SHALL BE RESPONSIBLE FOR WATERING PLANTS FOR THE FIRST YEAR AFTER ACCEPTANCE OF COMPLETION OF PLANTING FOR THE PROJECT. COUNTY WILL MAKE PROVISIONS FOR WATERING AS NEEDED FOR THE REMAINDER OF THE ESTABLISHMENT PERIOD AFTER THE FIRST YEAR.
- 12 CONTRACTOR SHALL REMOVE ALL TREE STAKES AT THE END OF ONE (1) YEAR.

TEMPORARY IRRIGATION NOTES:

- 1 VERIFY LOCATION OF EXISTING UTILITIES PRIOR TO CONSTRUCTION.
- 2 ALL WORK SHALL BE IN ACCORDANCE WITH SPECIFICATIONS SECTION 8-03
 "IRRIGATION SYSTEMS".

 3 CONTRACTOR SHALL PROTECT ALL EXISTING IMPROVEMENTS. DAMAGE TO THE
- 3 CONTRACTOR SHALL PROTECT ALL EXISTING IMPROVEMENTS. DAMAGE TO THE EXISTING IMPROVEMENTS SHALL BE REPAIRED OR REPLACED TO THE SOLE SATISFACTION OF THE OWNER AT NO COST.
- 4 CONTRACTOR SHALL BE RESPONSIBLE FOR PROVIDING A SCALED IRRIGATION PLAN AND APPLICABLE CONSTRUCTION DETAILS WHICH GRAPHICALLY IDENTIFIES THE LOCATION, SIZES, AND TYPES OF IRRIGATION EQUIPMENT PROPOSED FOR REVIEW AND APPROVAL BY OWNER'S REP. CONTRACTOR SHALL ALSO FIELD VERIFY STATIC PRESSURE PRIOR TO DESIGN PREPARTION.
- 5 ALL WORK SHALL BE IN COMPLIANCE WITH STATE AND LOCAL CODES.
- LOCATE ALL VALVES WITHIN ONE (1) FOOT OF THE MAINLINE.
- FIELD VERIFY ALL SPRINKLER HEAD LOCATIONS (FLAGGING) FOR REVIEW AND APPROVAL BY OWNER'S REP BEFORE TRENCHING.

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DRAWING TITLE

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NORTH PORTWALK AND SEAWALL F

336 Admiral Way; Edmonds, Was

PLANTING SITE PLAN & SCHEDULI

REVISIONS


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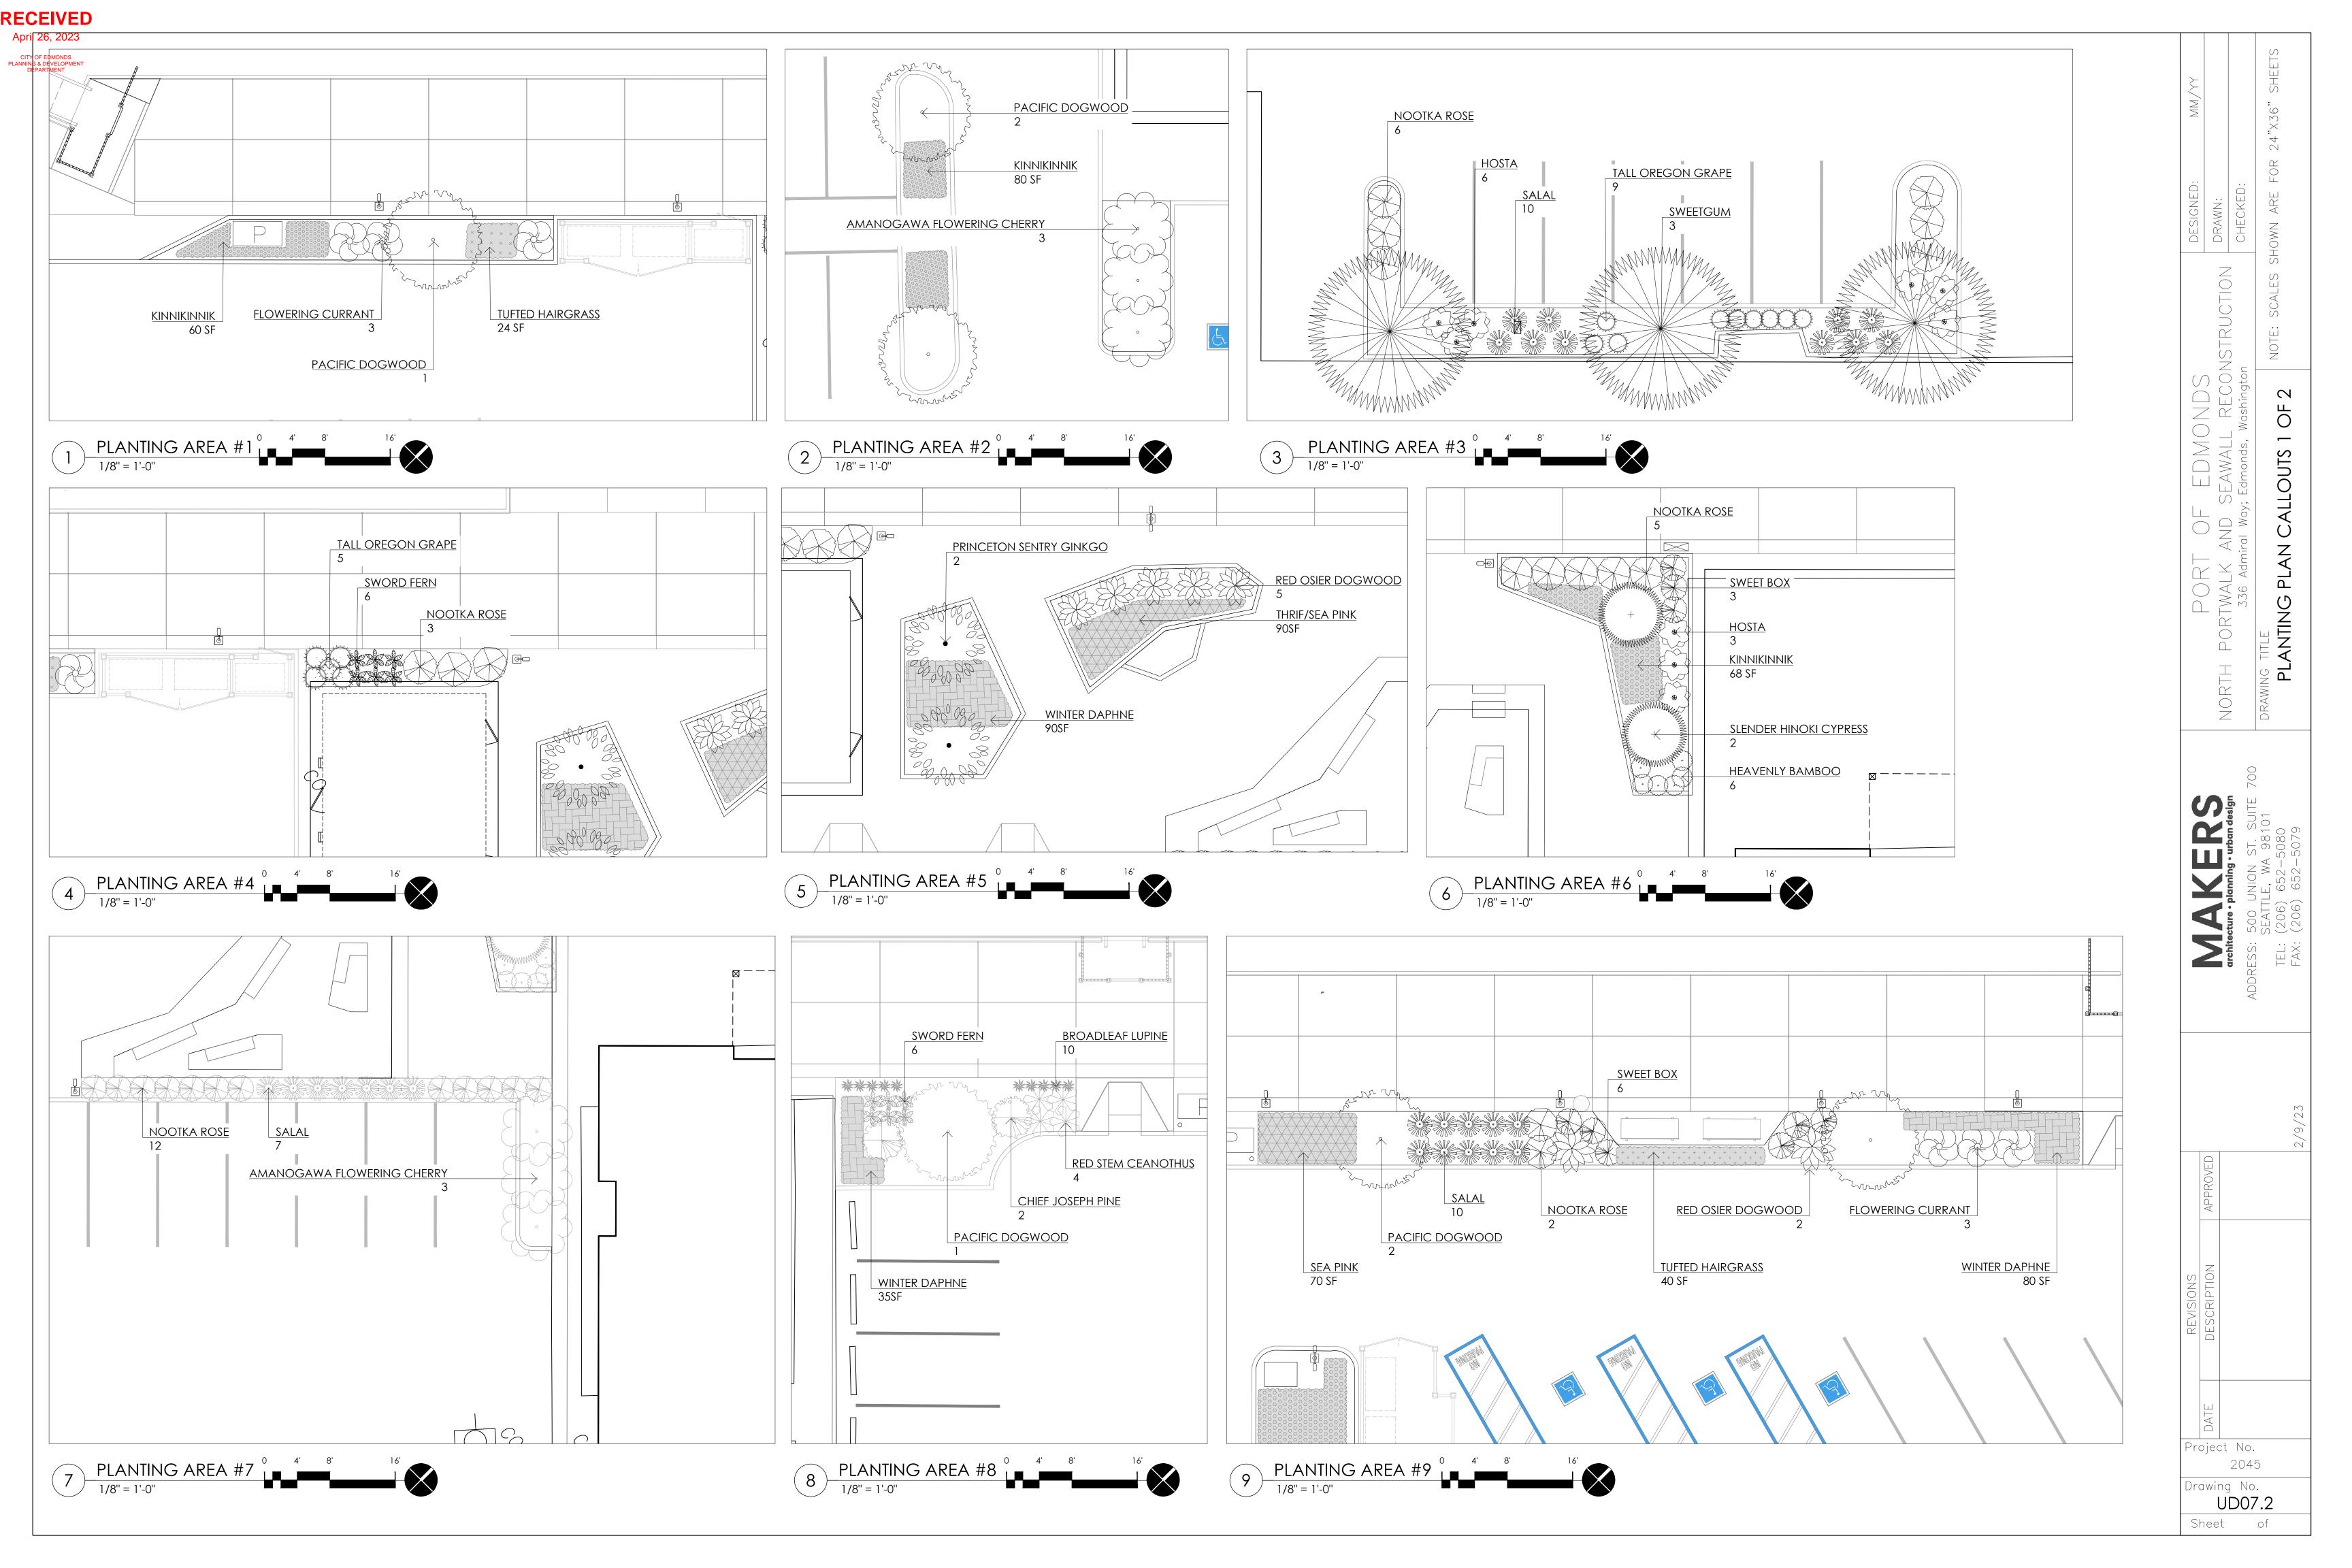
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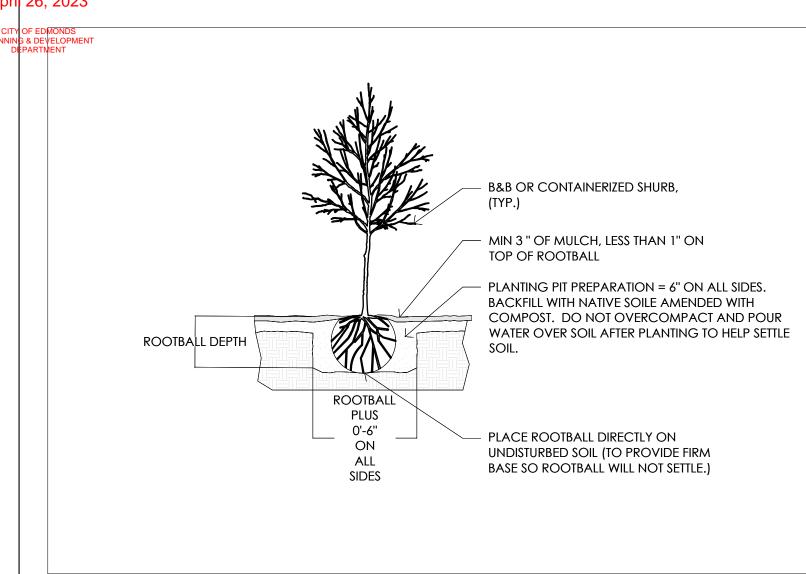
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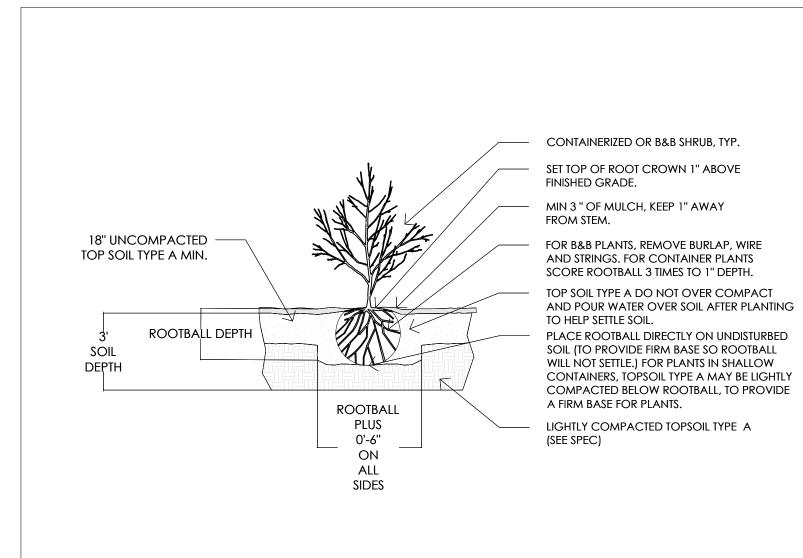
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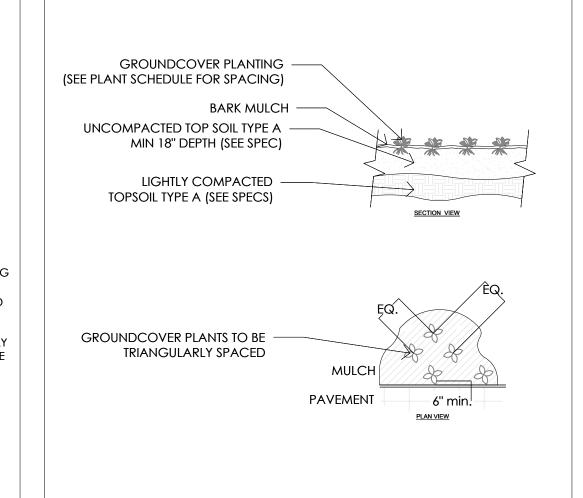




April 26, 202





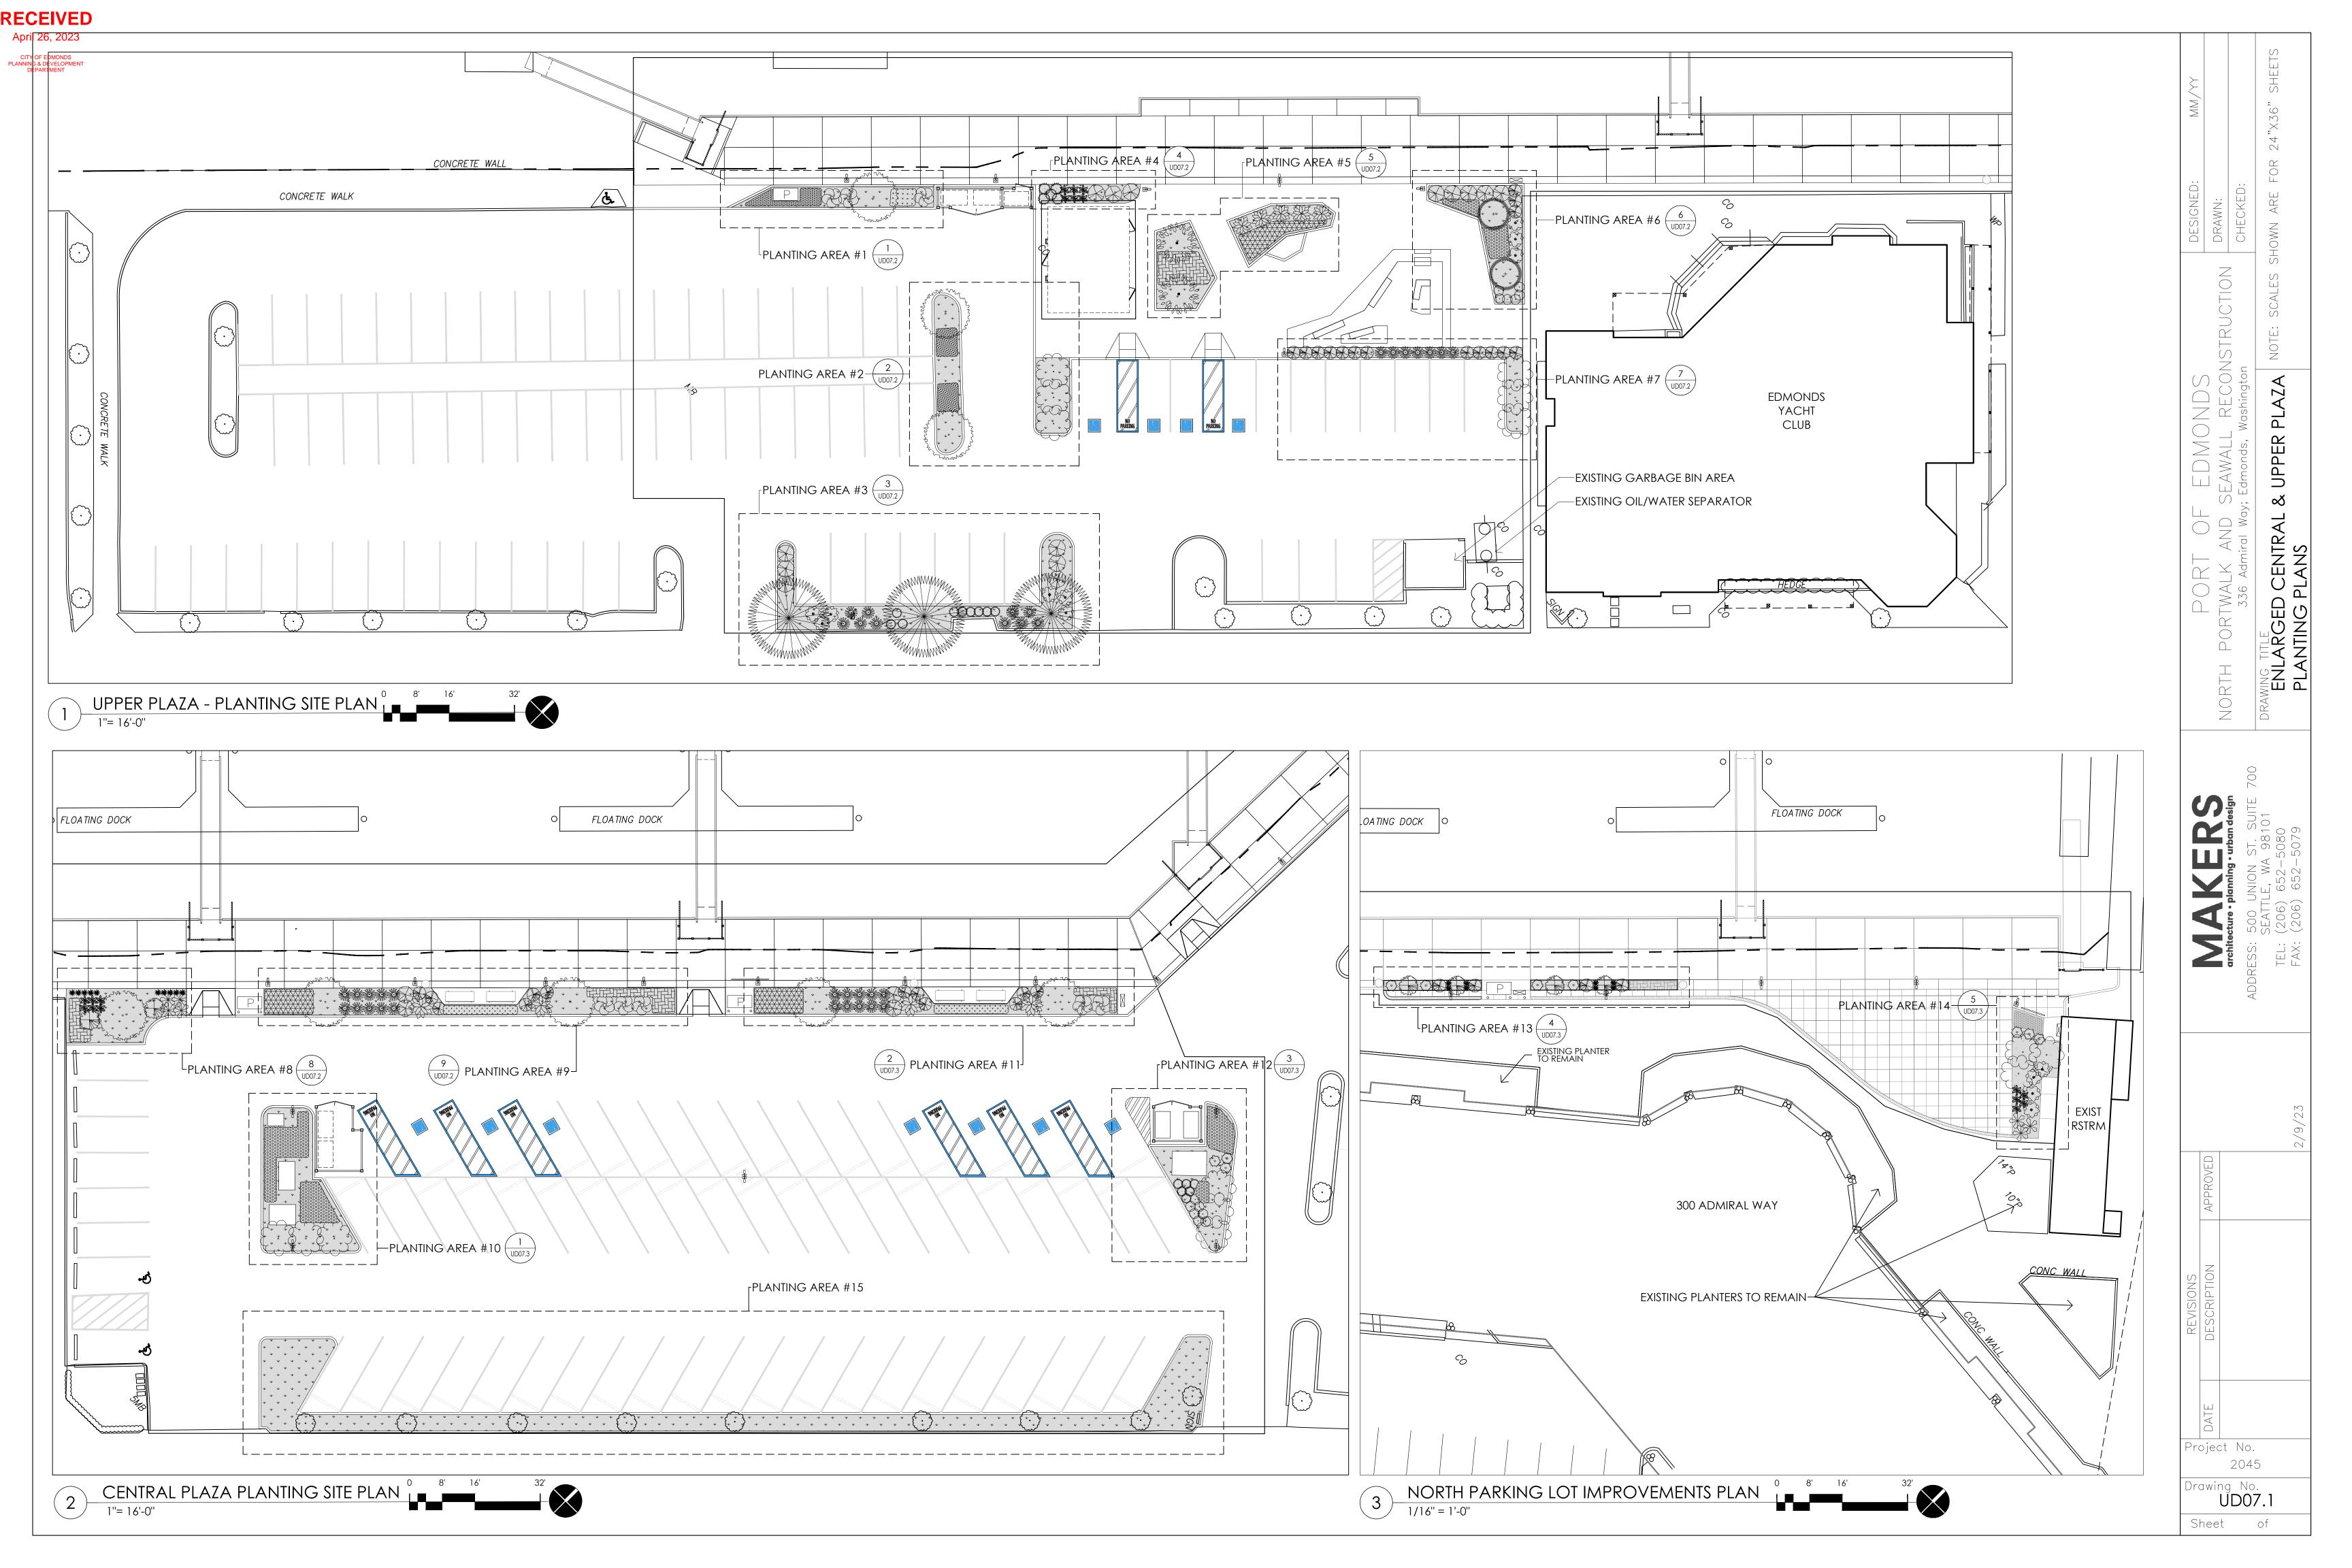

TREE PLANTING

NTS

2 SHRUB PLANTING
NTS

3 GROUNDCOVER PLANTING

NTS

NORTH PORTWALK AND SEAWALL RECONSTRUCTION
336 Admiral Way; Edmonds, Washington
CHECKE

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